




PP19912521 ①

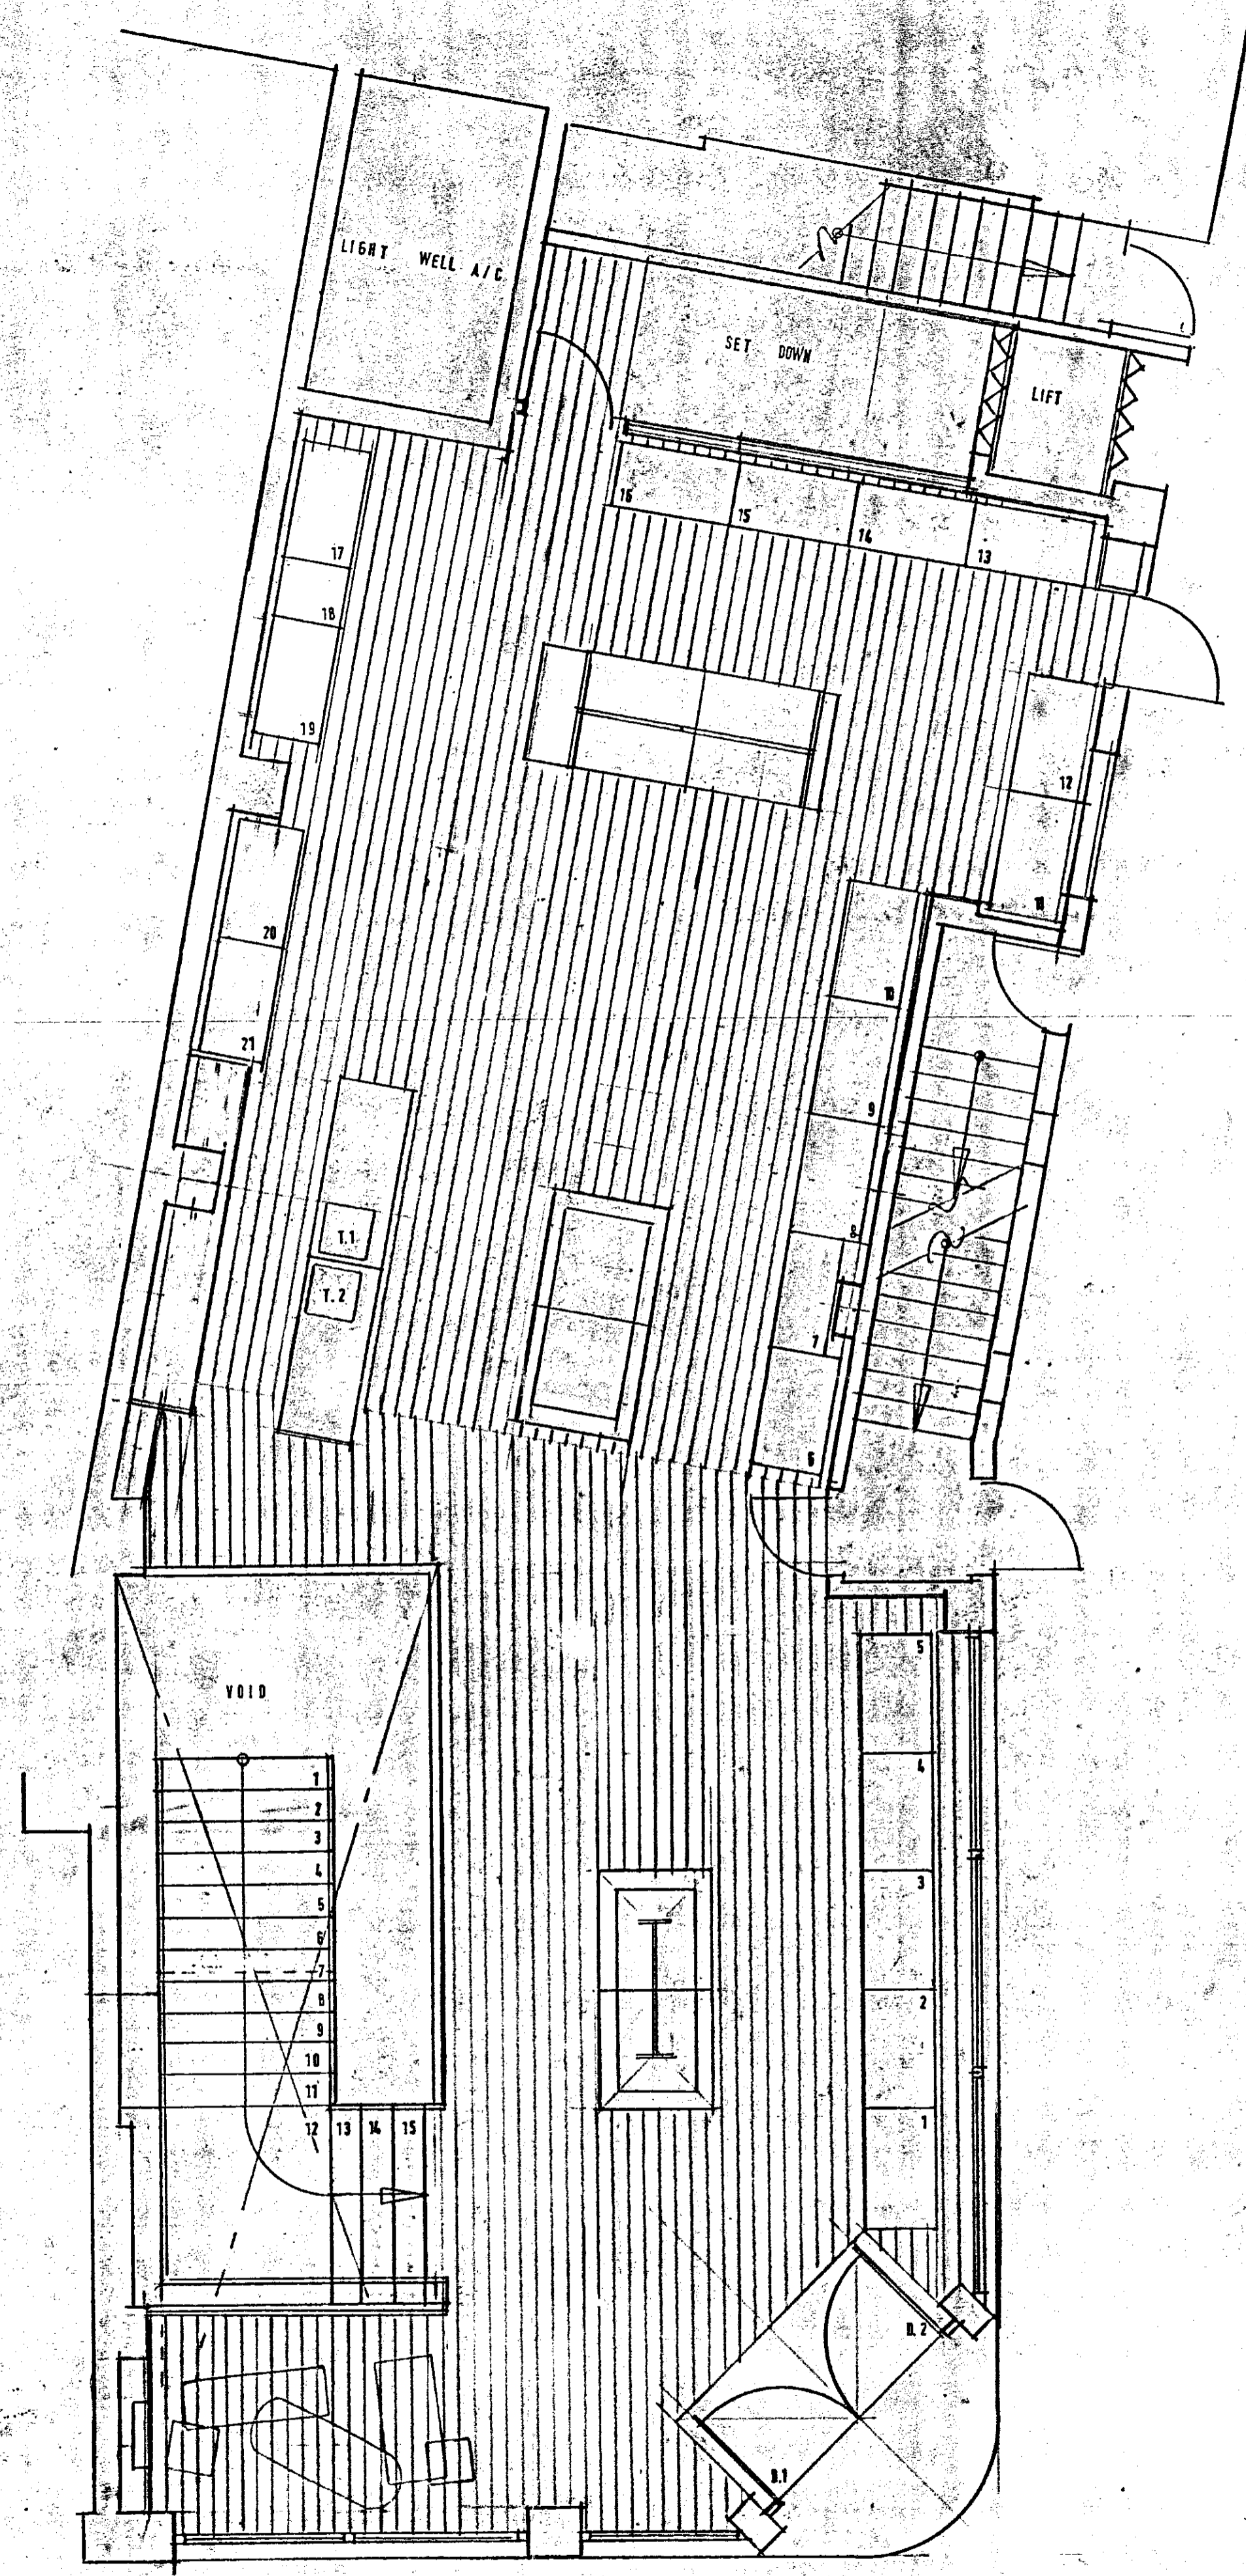

GROUND PROPOSED

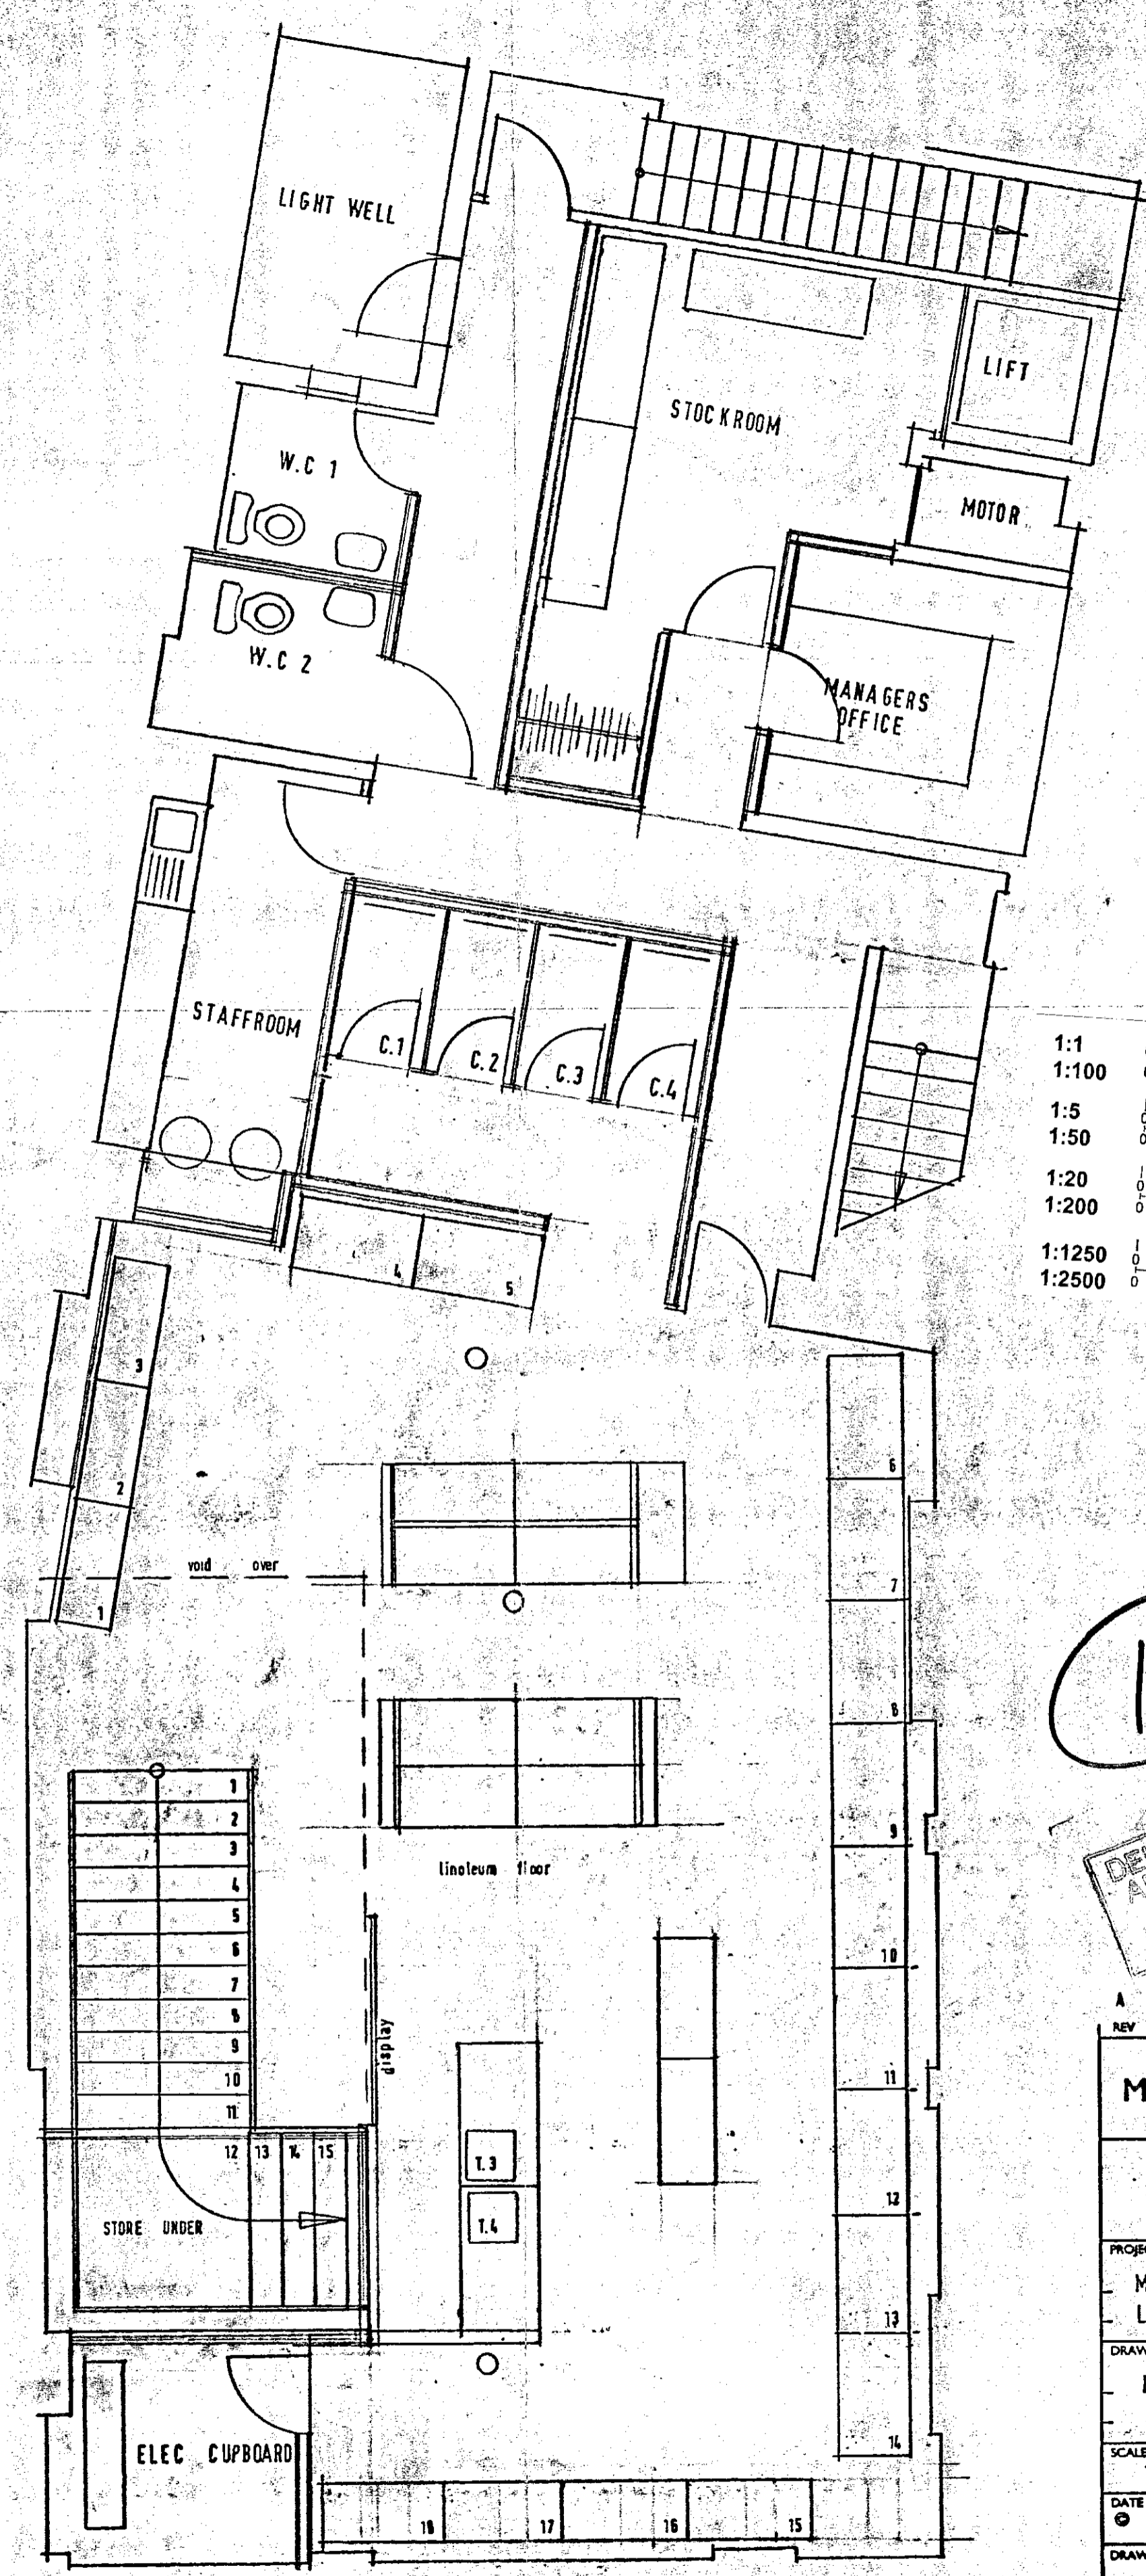

BASEMENT PROPOSED 1:50

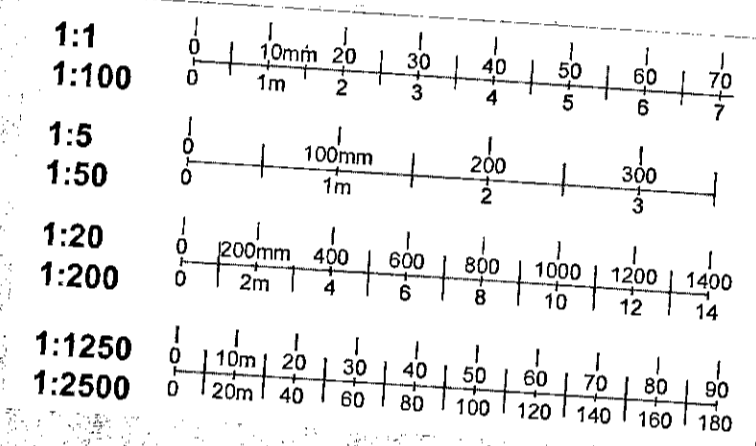

PP932521



DELEGATED
APPROVAL
2.2 MINS ZONE

REV	DATE	DESCRIPTION
A	9.12.99	UPDATE LAYOUT

MCDANIEL WOOLF

PROJECT
MUJI 118/118A KINGS ROAD
LONDON

DRAWING TITLE
PROPOSED PLANS

SCALE 1:50 DRAWN RW

DATE 3.12.99 CHECKED



DRAWING NUMBER
087.01

REVISION	DATE	DESCRIPTION
A		

DO NOT SCALE FROM THE DRAWING
VERIFY DIMENSIONS BY SITE MEASUREMENTS
READ THE DRAWING IN CONJUNCTION WITH THE LATEST
MECHANICAL, ELECTRICAL, PLUMBING AND STRUCTURAL ENGINEERING DRAWINGS

H.E.K. & C.
TOWN PLANNING
10 DEC 1999
RECEIVED


DWG No.

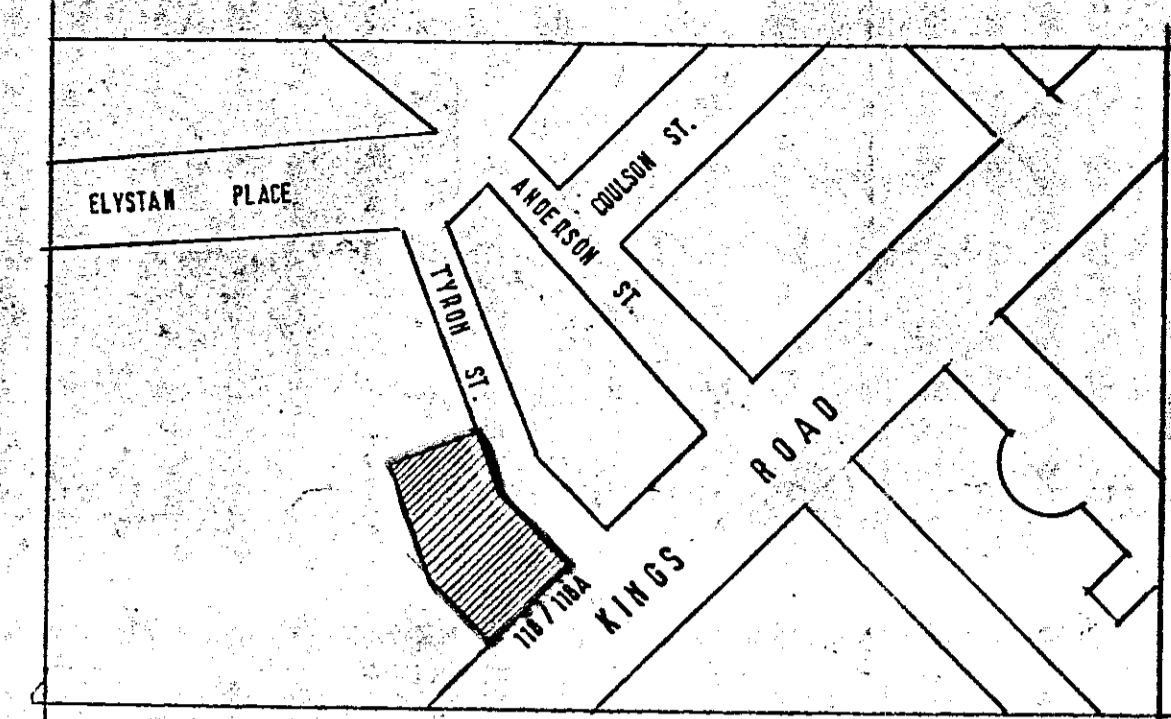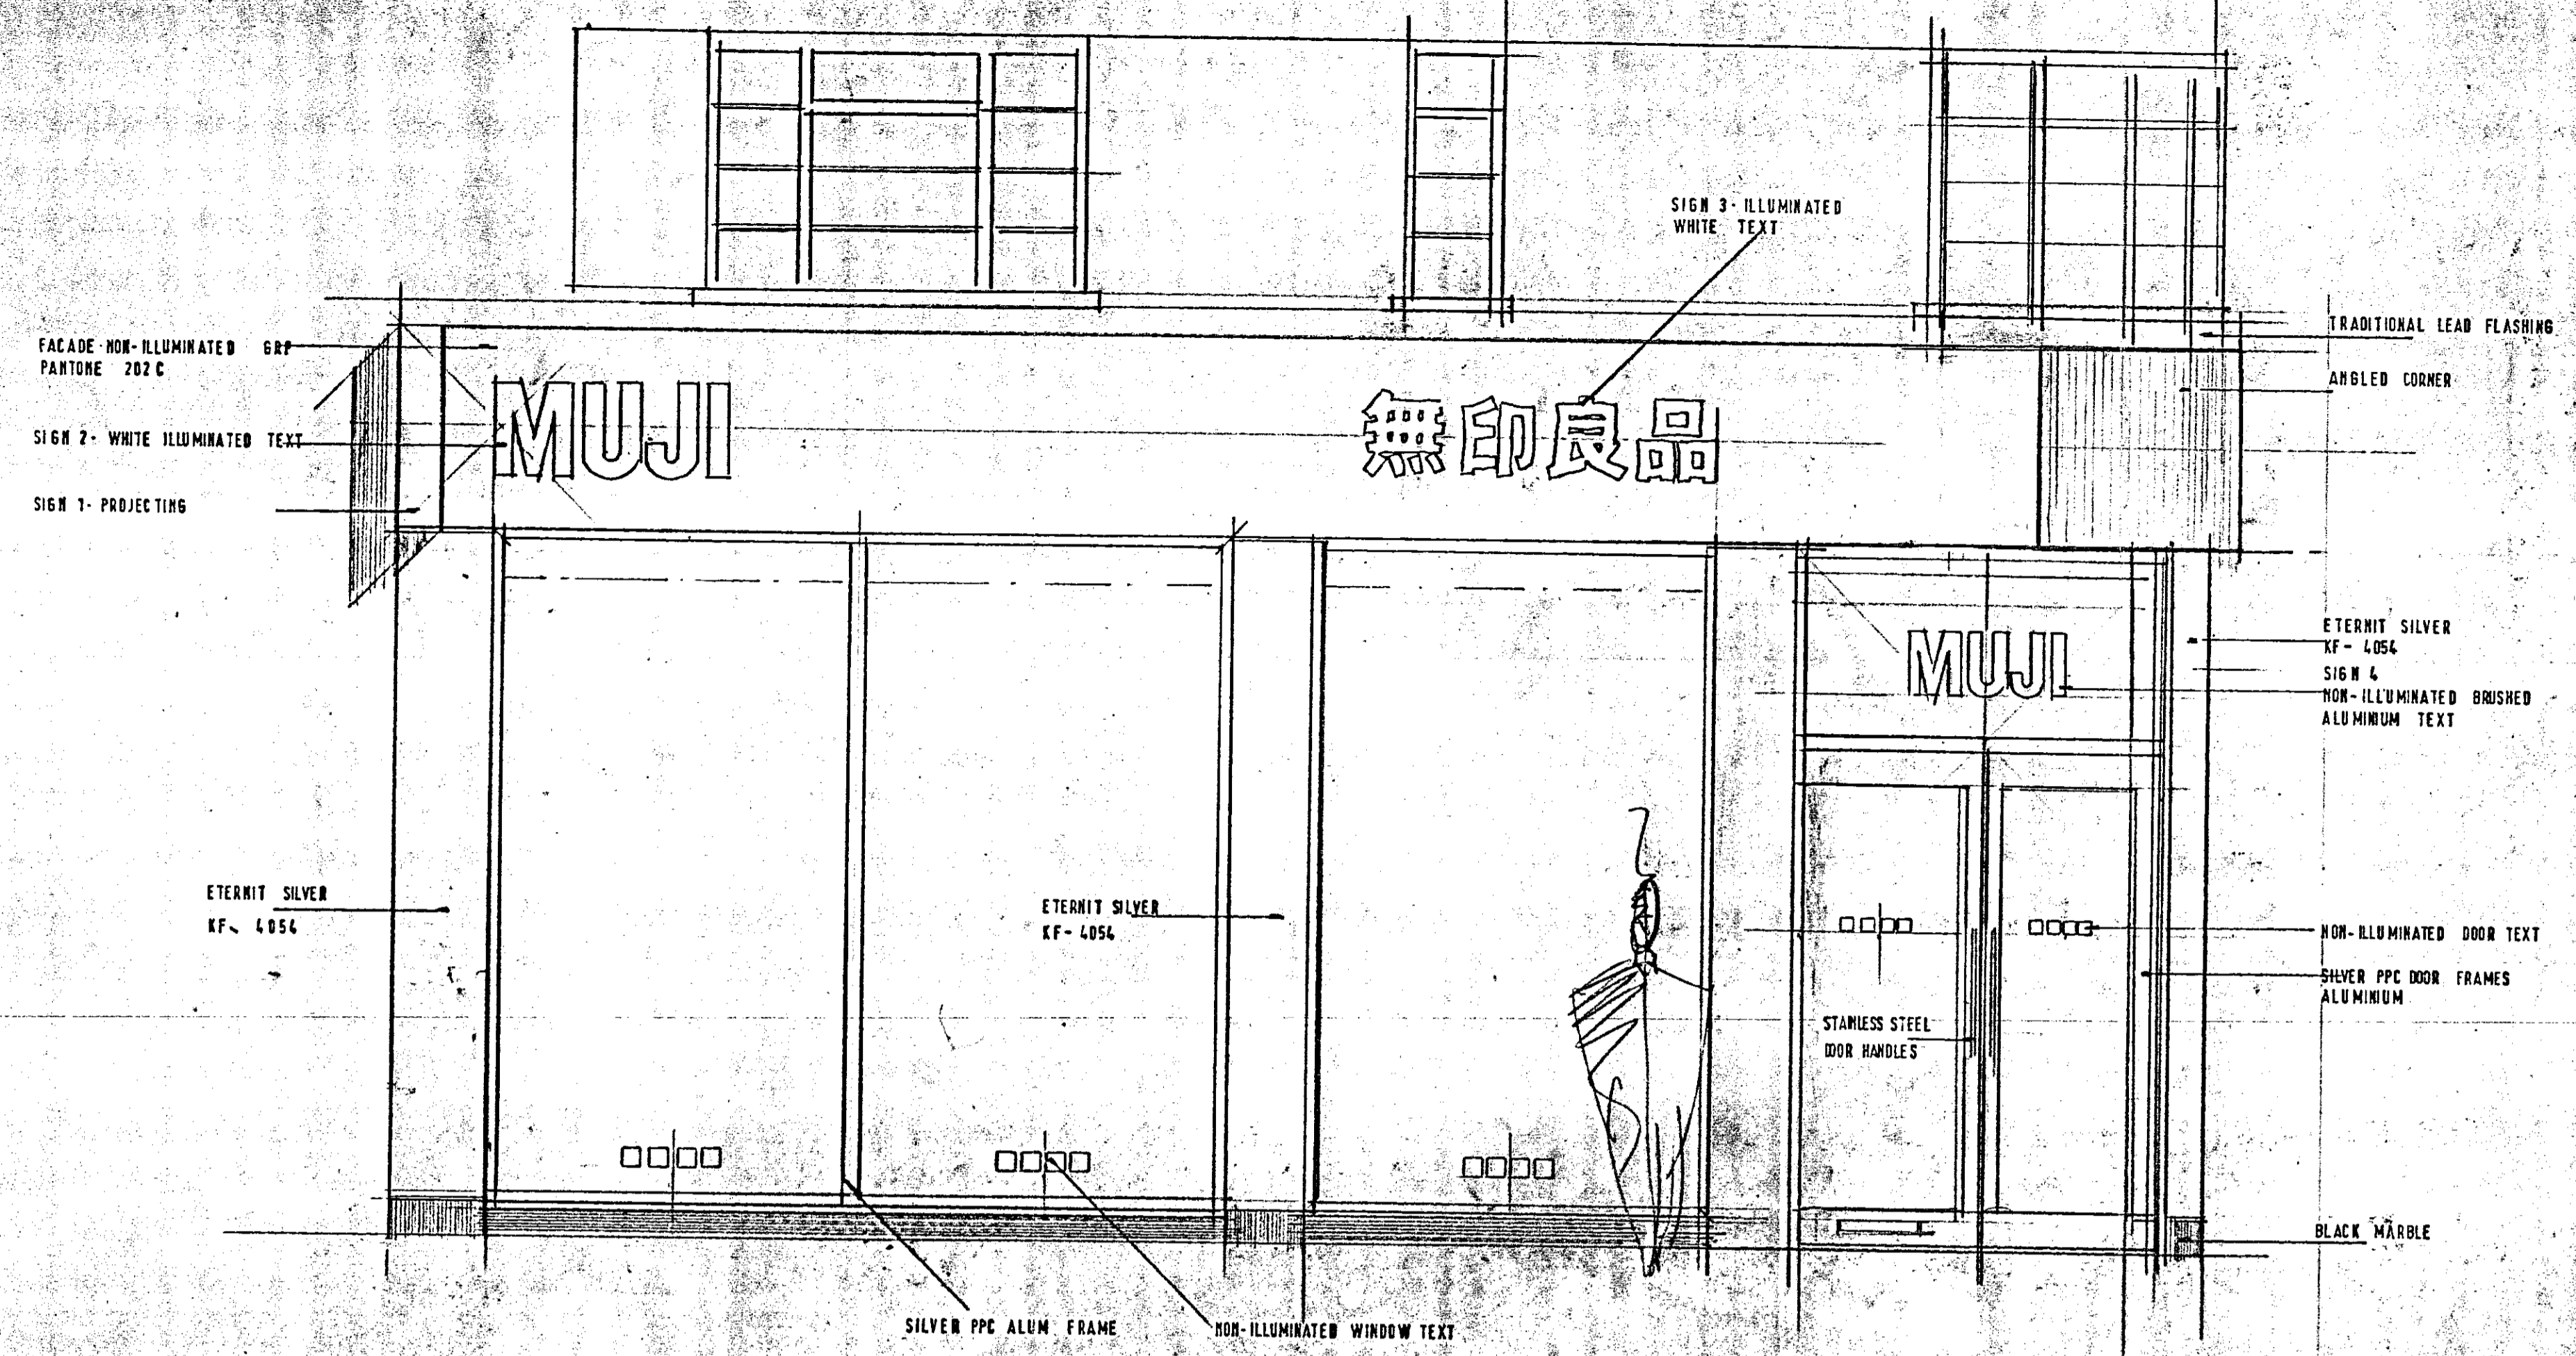

LOCATION DIAGRAMME n.t.s

1:1	0 10mm 20 30 40 50 60 70
1:100	0 1m 2 3 4 5 6 7
1:5	0 100mm 200 300
1:50	0 1m 2 3
1:20	0 200mm 400 600 800 1000 1200 1400
1:200	0 2m 4 6 8 10 12 14
1:1250	0 110m 20 30 40 50 60 70 80 90
1:2500	0 20m 40 60 80 100 120 140 160 180

KINGS ROAD ELEVATION 1.25

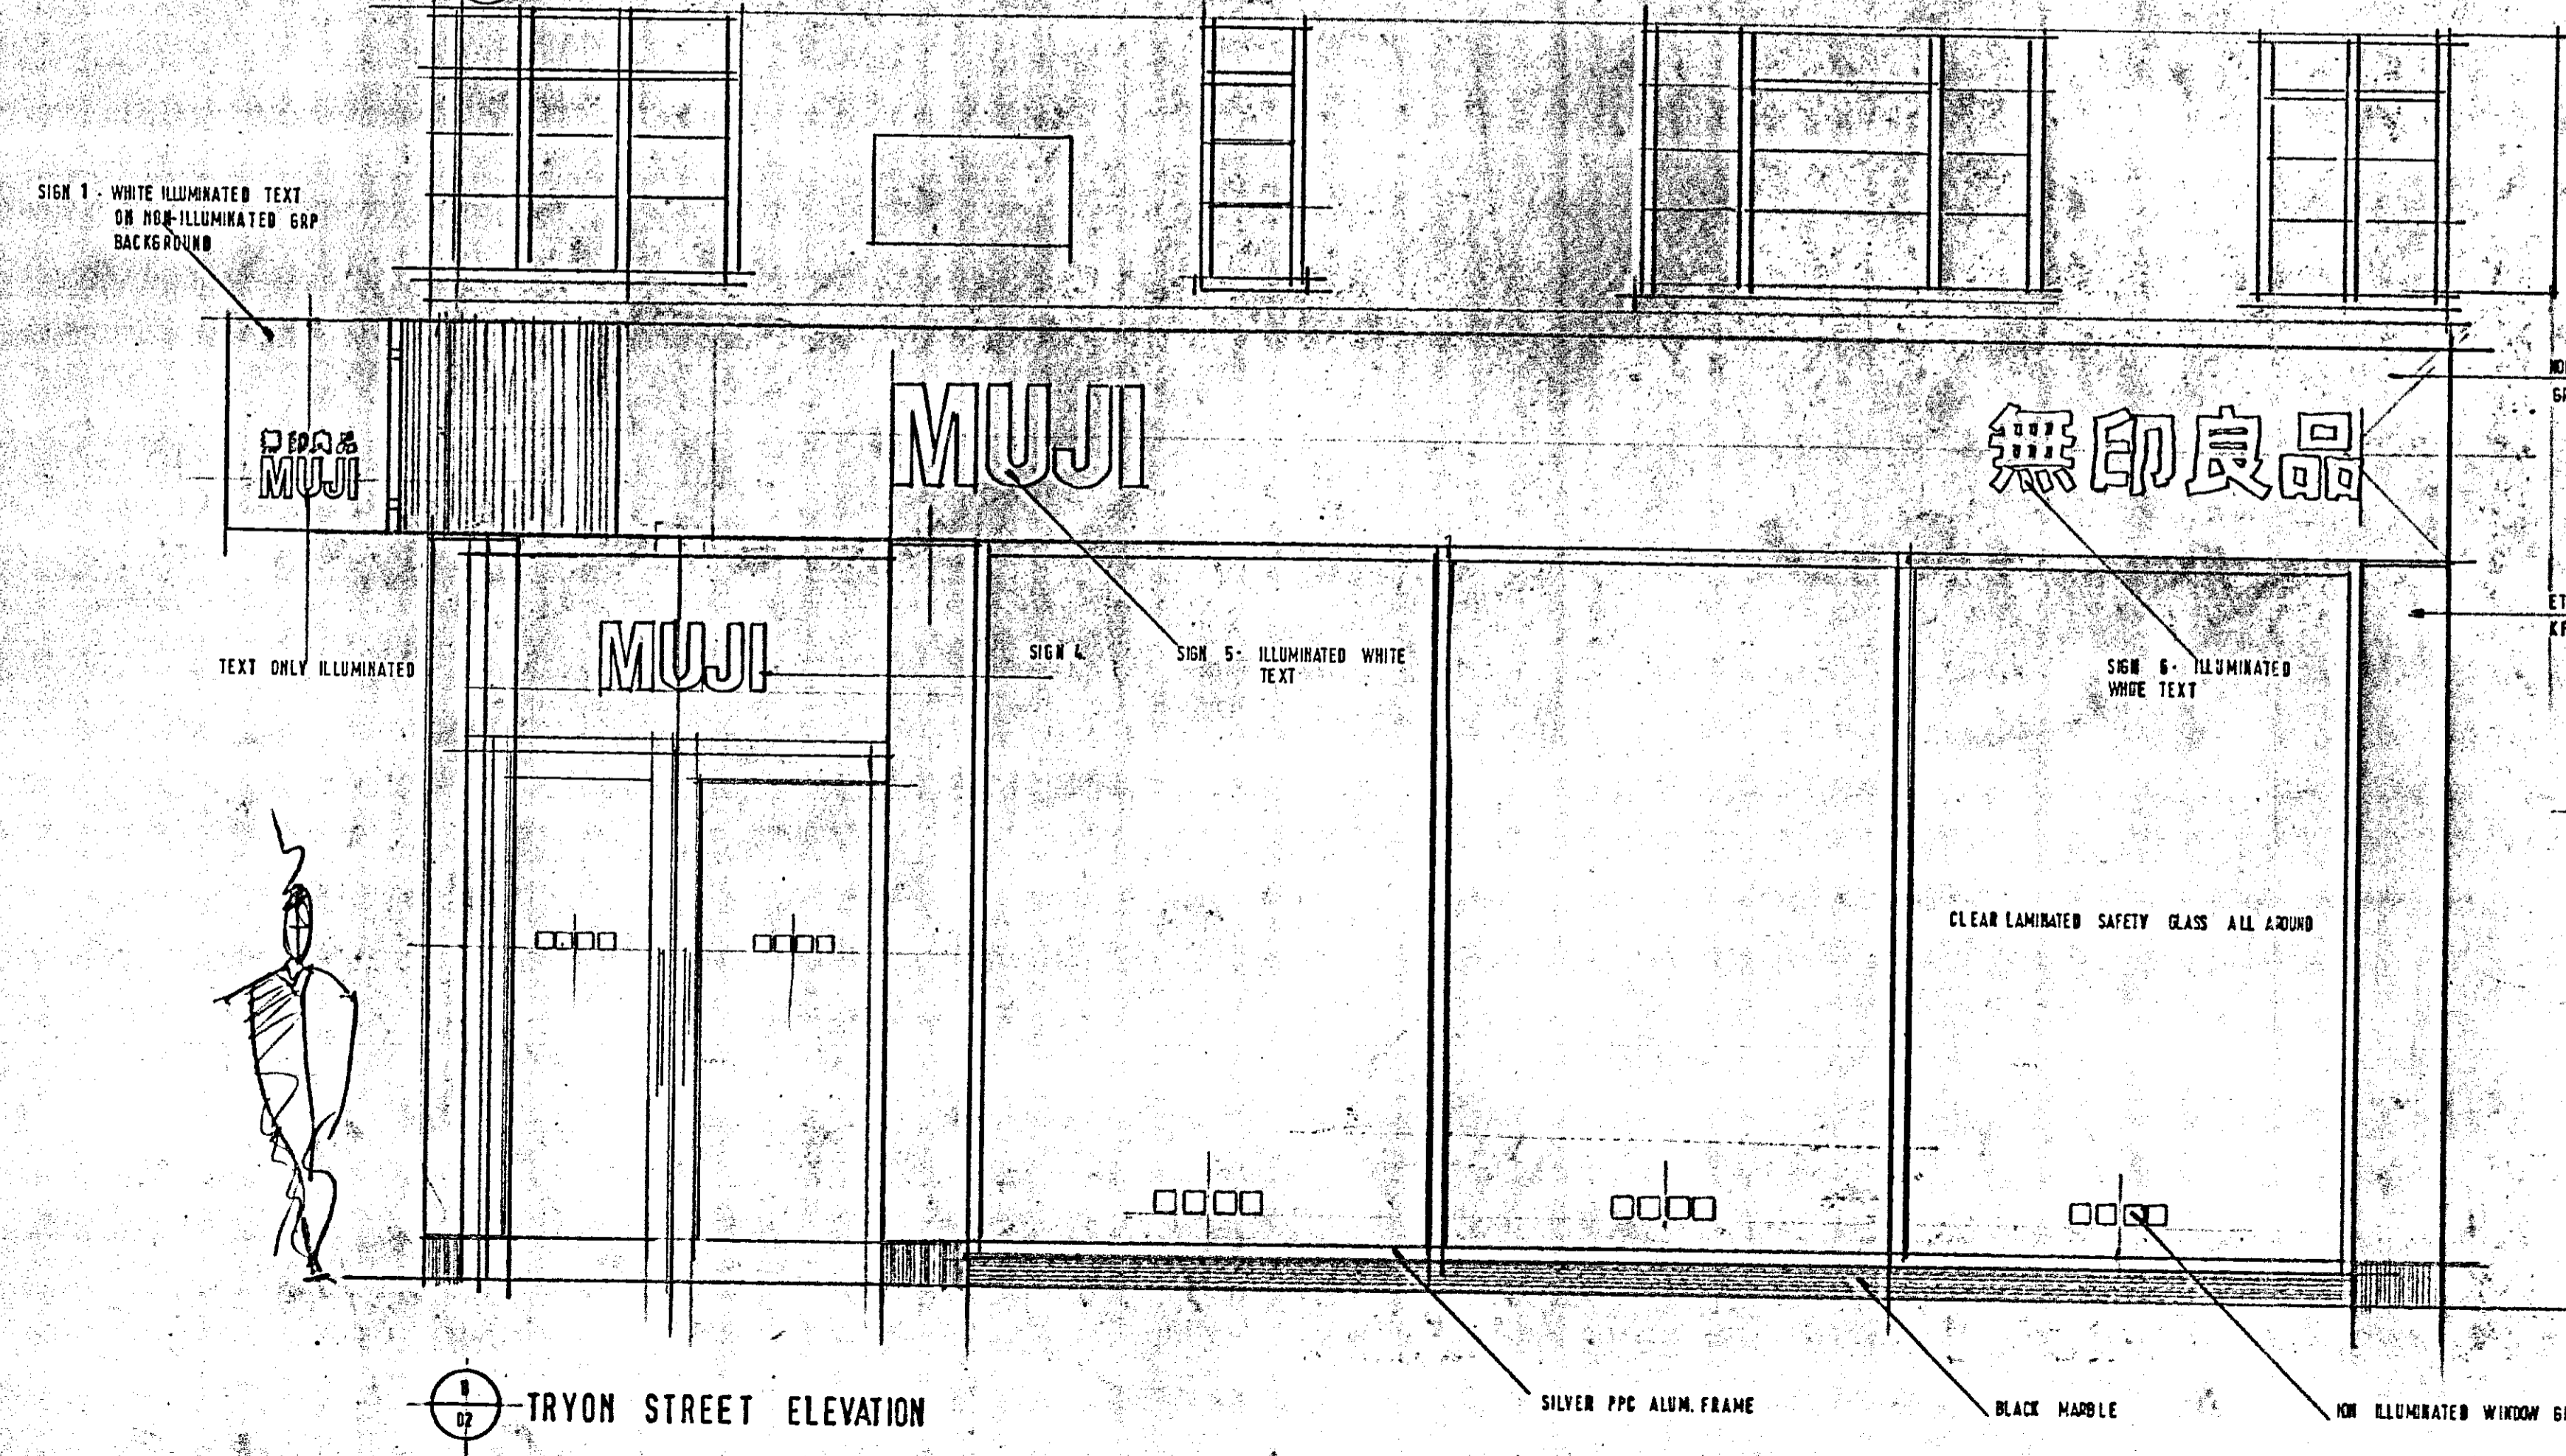

TRYON STREET ELEVATION

PP992521

TOWN PLANNING
10 DEC 1999
RECEIVED


DELEGATED
APPROVAL
22 MAR 2000

②


REV	DESCRIPTION	DATE
McDANIEL WOLF		
PROJECT		
MUJI 118 / 118A KINGS ROAD LONDON		
DRAWING TITLE		
PROPOSED FRONT ELEVATIONS		
SCALE	1.25	DRAWN
DATE	04.12.99	CHECKED
DRAWING NUMBER		
087.02		
REVISION		

DO NOT SCALE FROM THIS DRAWING
MEASURE DIMENSIONS BY USE OF CALIPERS
READ THE DRAWING IN CONJUNCTION WITH THE LATEST
MECHANICAL AND ELECTRICAL ENGINEERING AND STRUCTURAL ENGINEERING DRAWINGS


15.
Floor to Floor
2360 +
120
2480

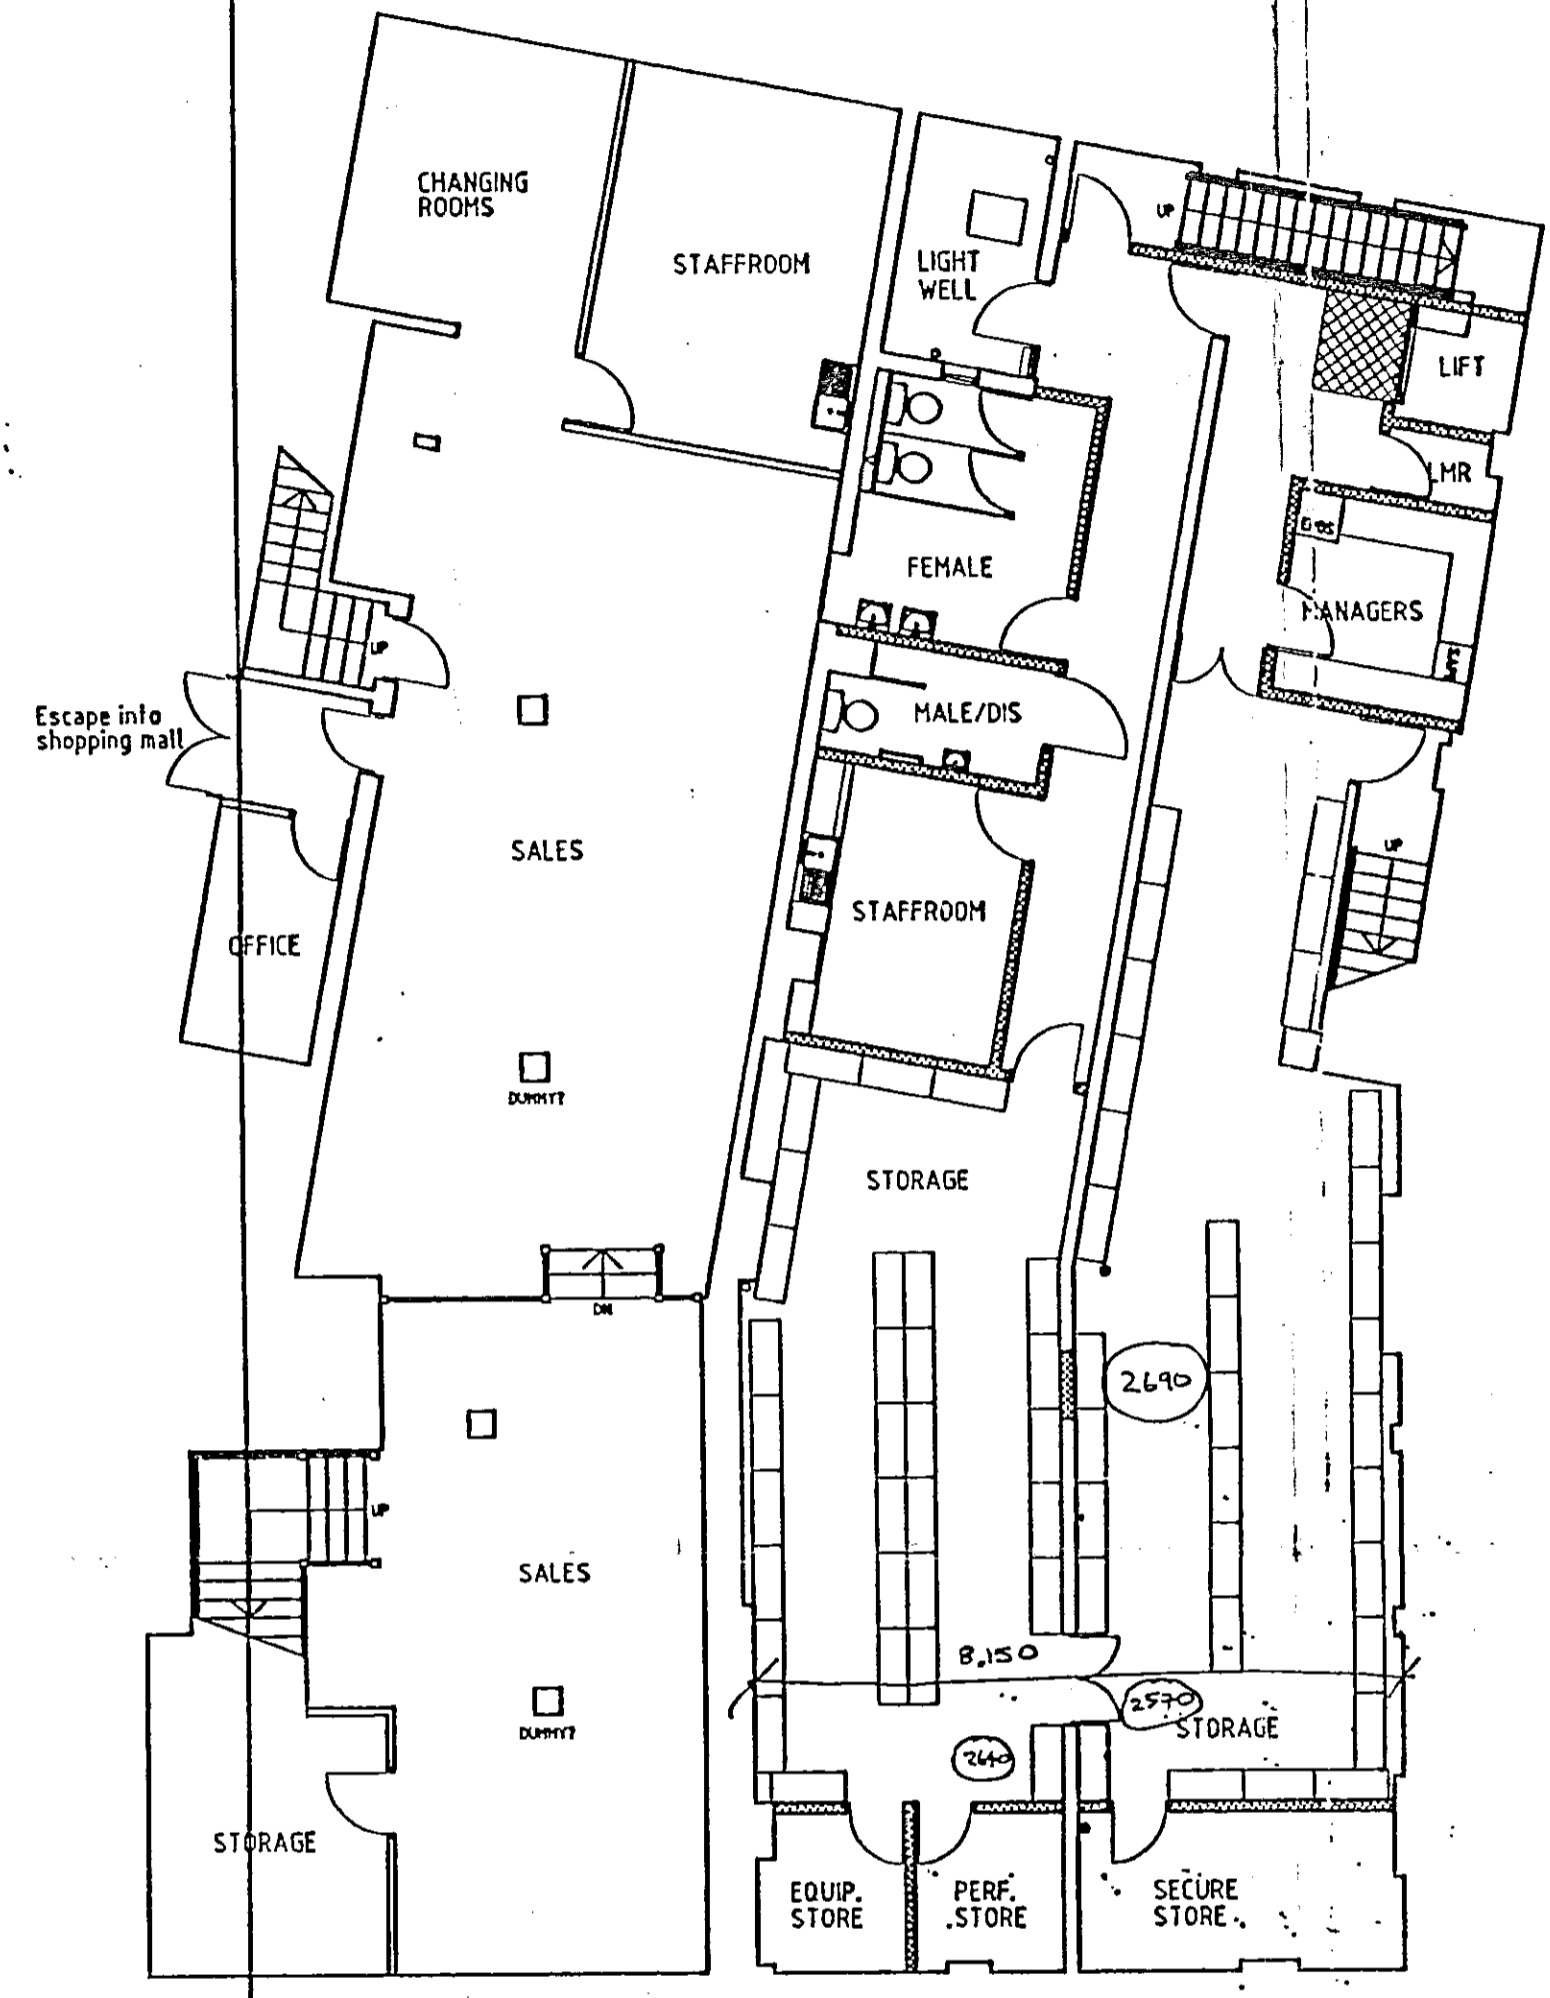



BASEMENT PLAN

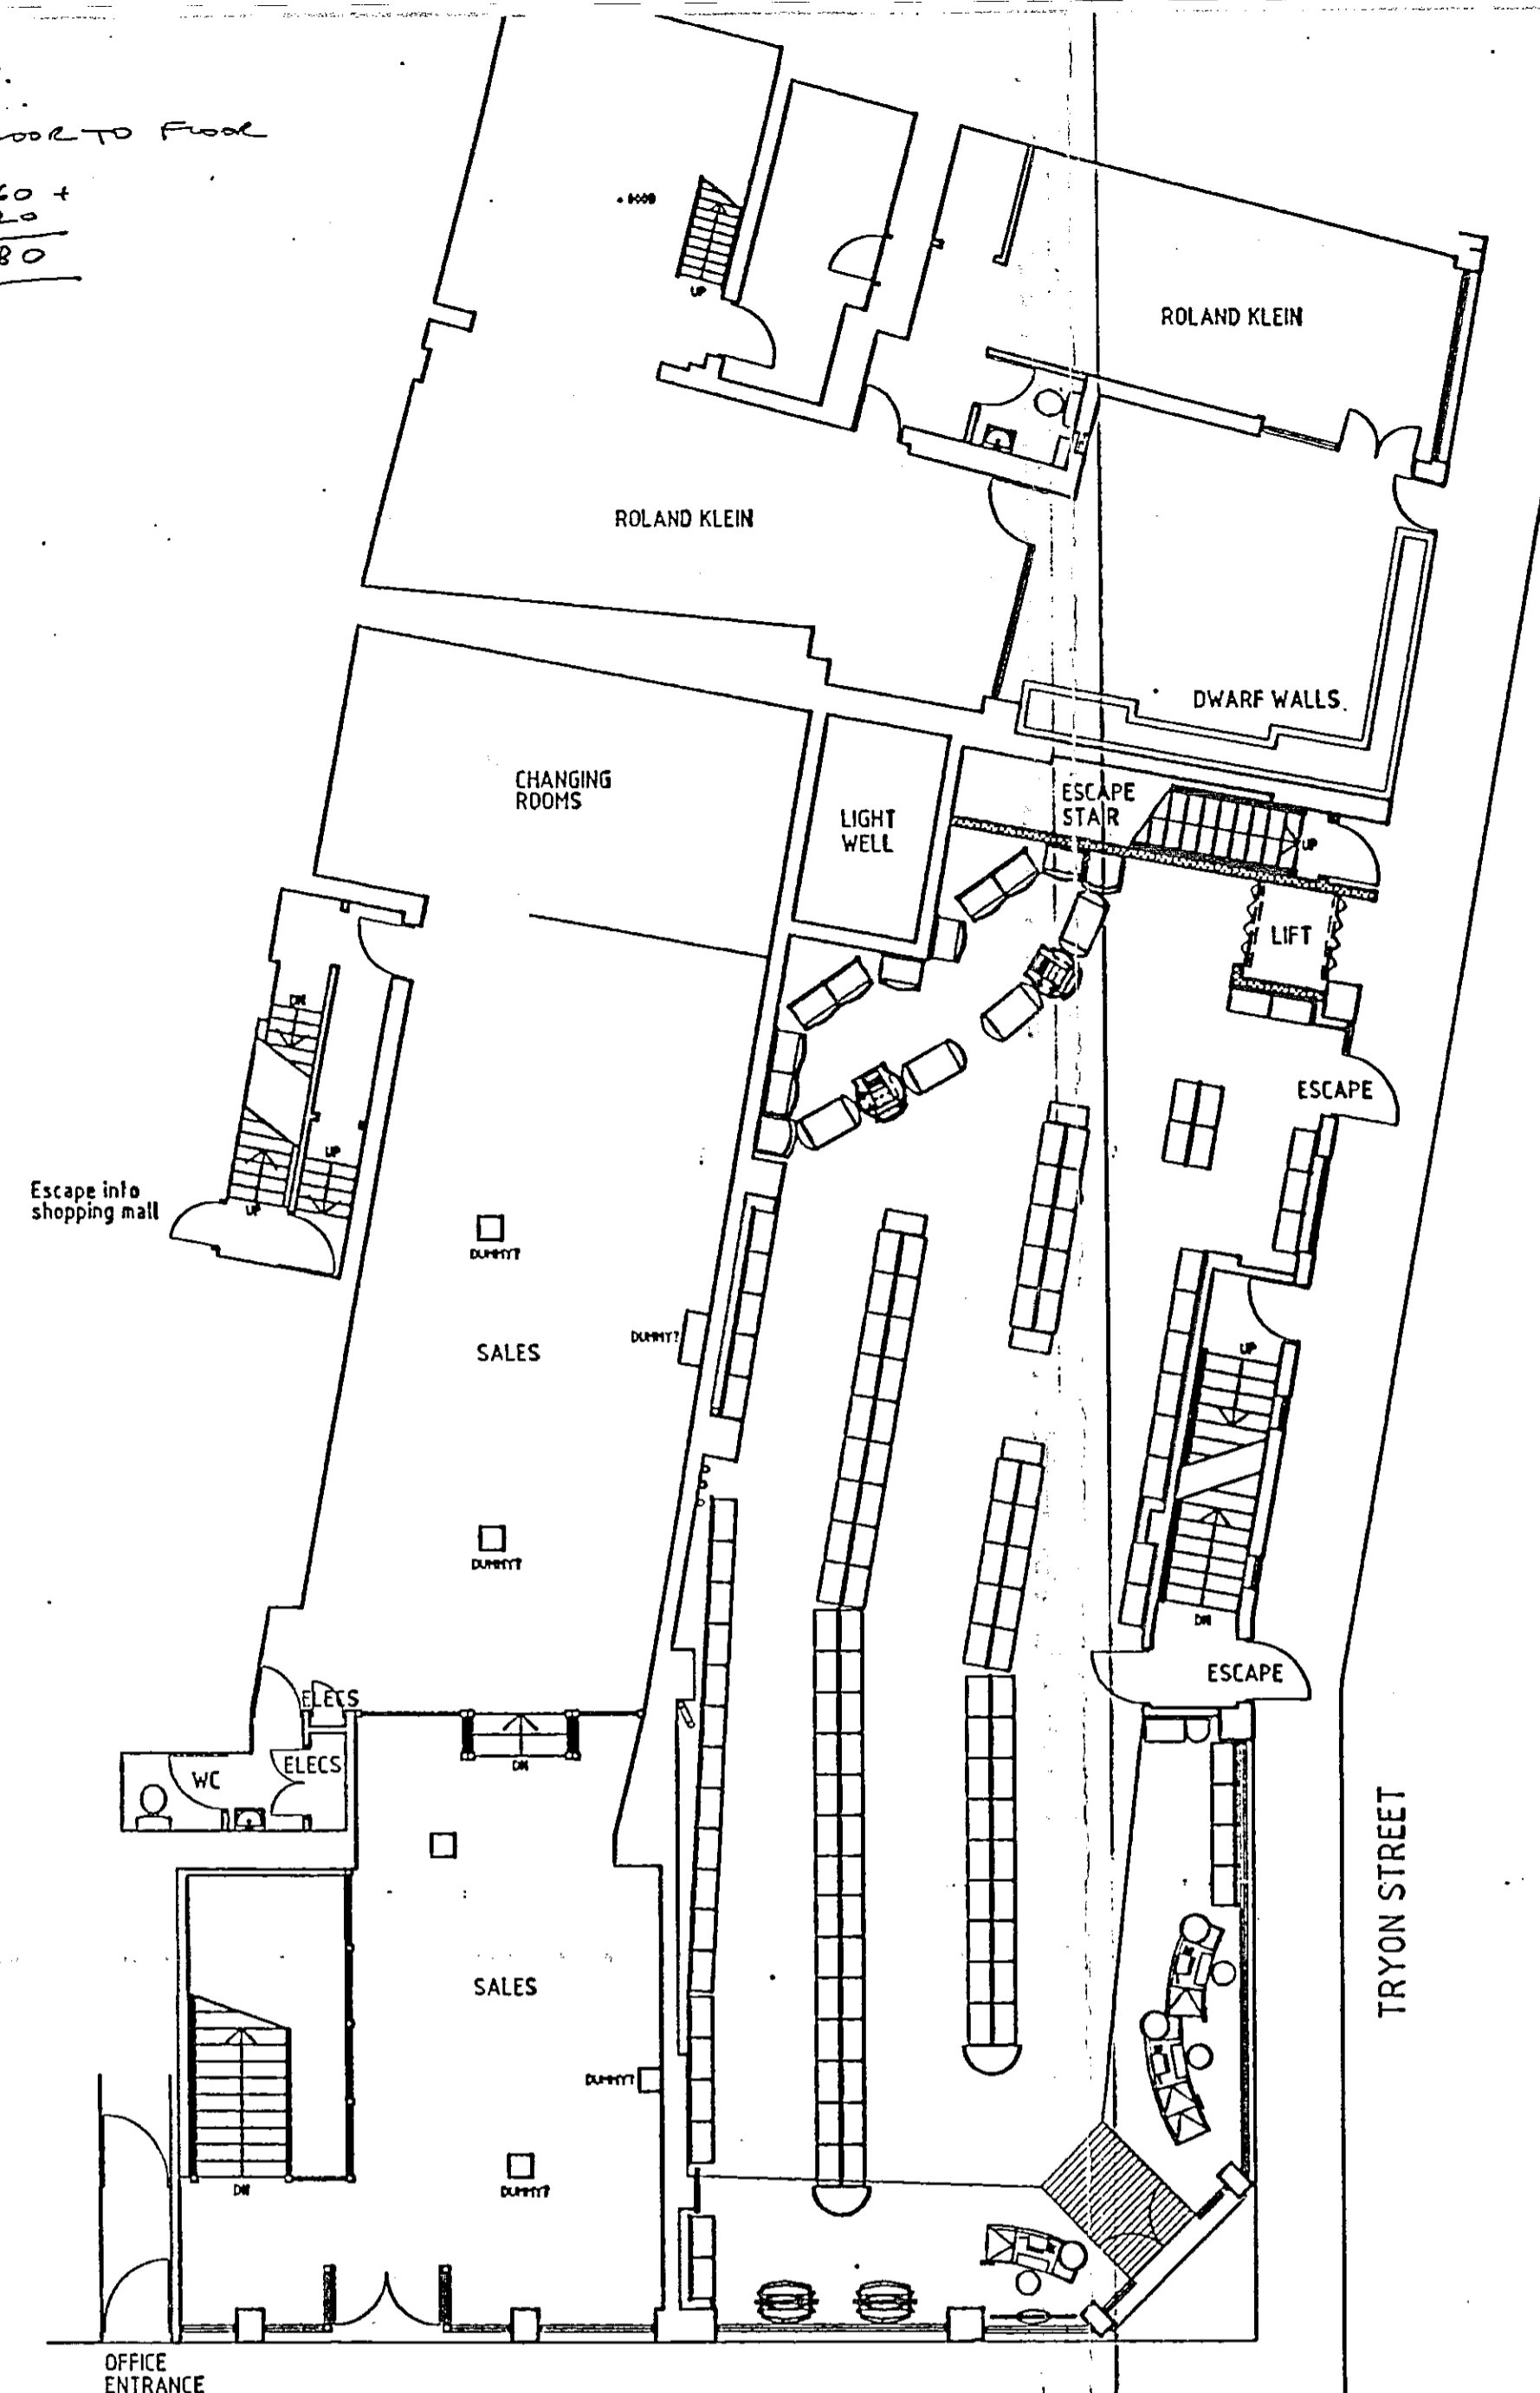

GROUND FLOOR PLAN

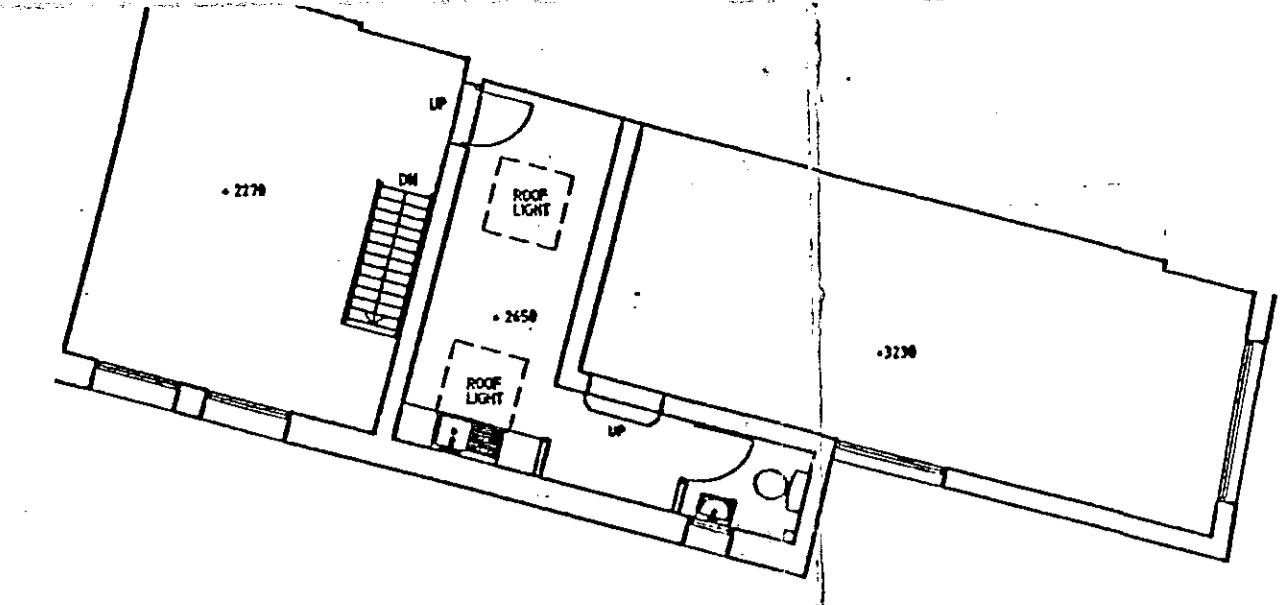

FIRST FLOOR PLAN

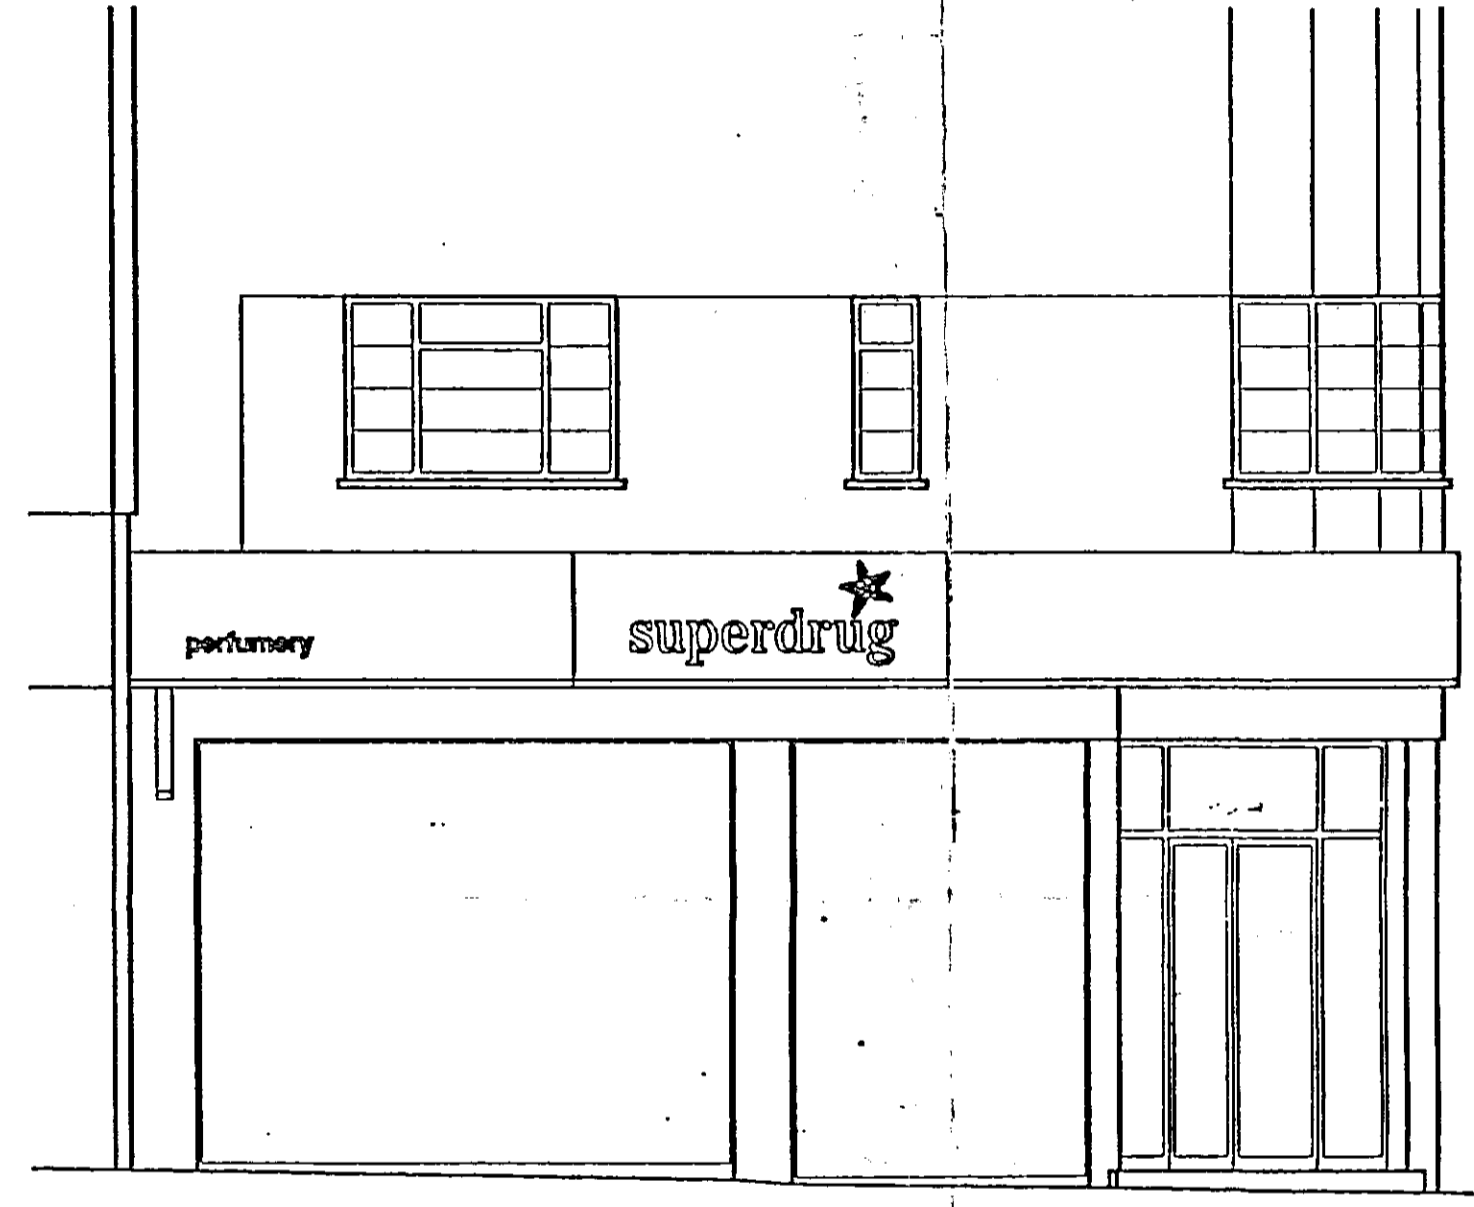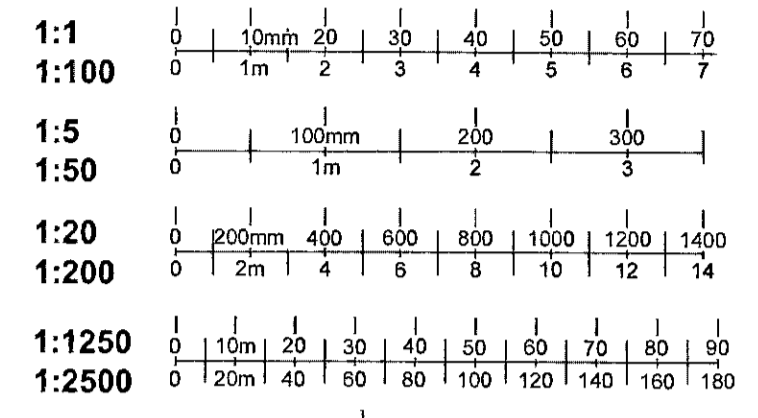

KINGS ROAD ELEVATION (1:50)




TRYON STREET ELEVATION (1:50)

PP992521
PLANNING
TOWN PLANNING
10 DEC 1999
RECEIVED

DELEGATED
APPROVAL
22 MAR 2000

3


REV	DESCRIPTION	DATE
	MCDANIEL WOOLF	
PROJECT		
MU11 118/118A KINGS ROAD LONDON		
DRAWING TITLE		
EXISTING SITE INFORMATION		
SCALE	DRAWN	
N.T.S		
DATE	CHECKED	
12.99		
DRAWING NUMBER		
087.03		
REVISION		
DO NOT SCALE FROM THE DRAWING MEASUREMENTS TO BE TAKEN FROM THE ORIGINAL DRAWING READ THE DRAWING IN CONJUNCTION WITH THE LATEST MECHANICAL, ELECTRICAL, ENGINEERING AND STRUCTURAL DRAWINGS		

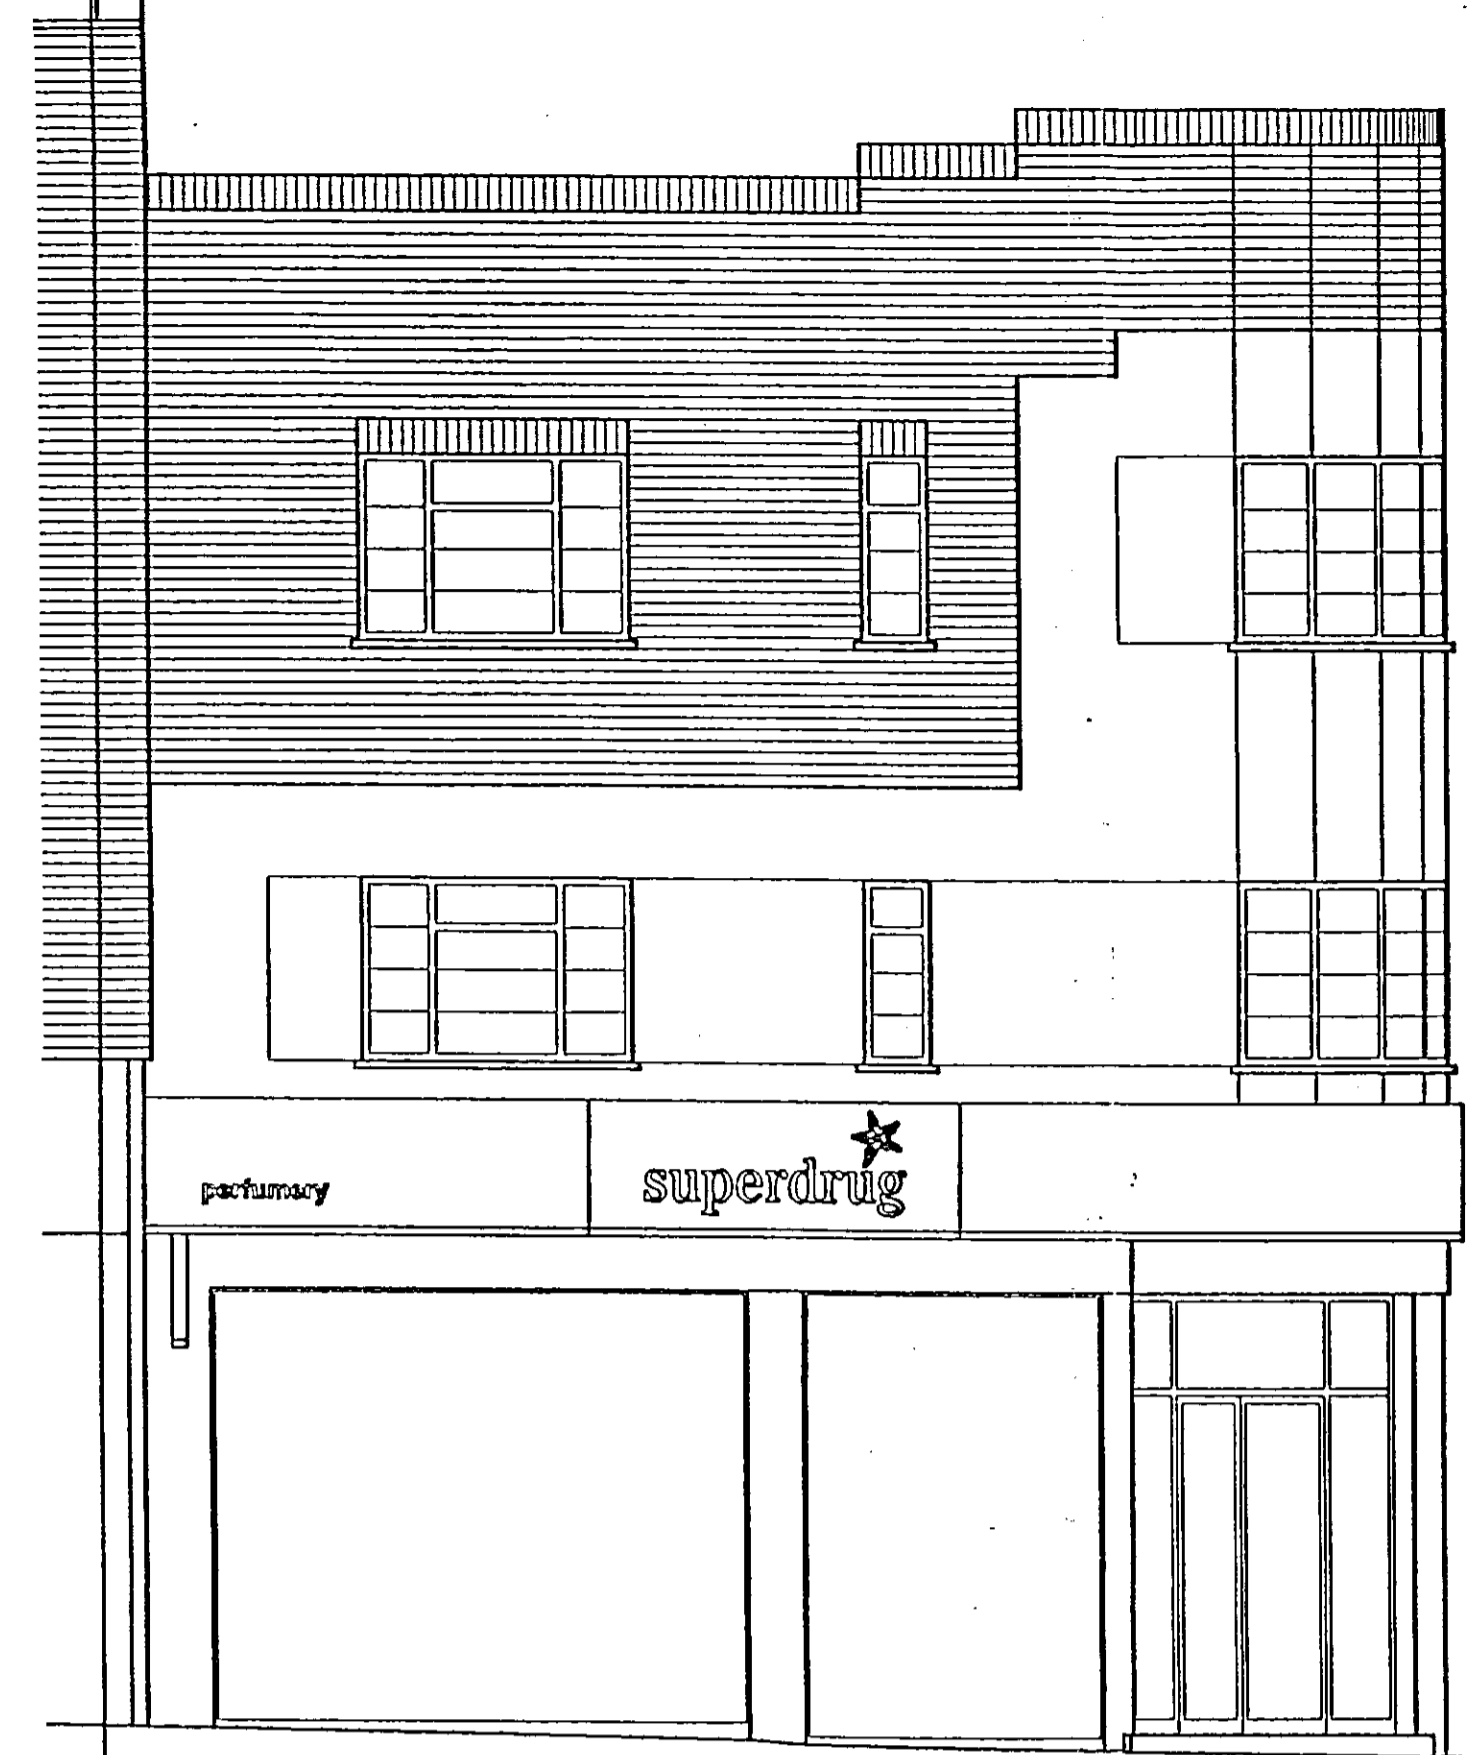

KINGS ROAD ELEVATION



TRYON STREET ELEVATION

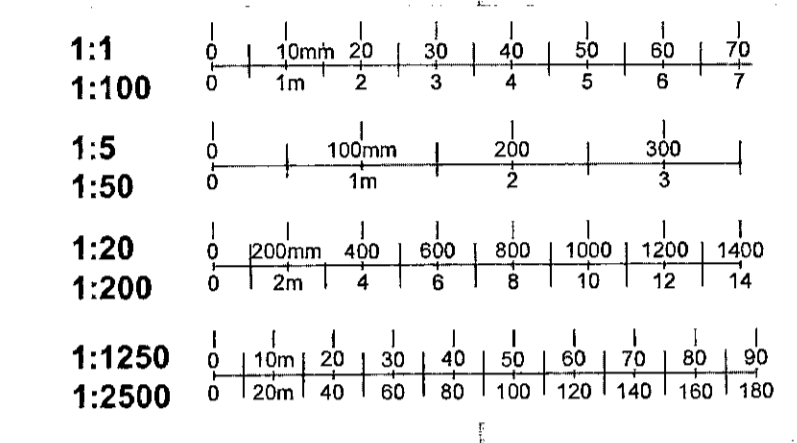

PP992521
 P.B.K. & C. LTD
 TOWN PLANNING
 10 DEC 1999
 RECEIVED

DELEGATED
 APPROVAL
 22 MAR 2000

(4)

REV	DESCRIPTION	DATE
	MCDANIEL WOLF	
PROJECT		
MUJI 118 / 118A KINGS ROAD LONDON		
DRAWING TITLE		
EXISTING ELEVATIONS		
SCALE	DRAWN	
N.T.S.		
DATE	CHECKED	
12.99		
DRAWING NUMBER		
087.04		
REVISION		
DO NOT SCALE FROM THIS DRAWING VERIFY DIMENSIONS BY SITE MEASUREMENT READ THE DRAWING IN CONJUNCTION WITH THE LATEST MECHANICAL AND ELECTRICAL DRAWINGS AND STRUCTURAL ENGINEERING DRAWINGS		